THE BLANTON HOUSE FRONT ENTRY IMPROVEMENTS

625 North Washington Street, Danville, IN 46122

Issued for 100% Construction Drawings October 2, 2025

Prepared for:

Owner




Prepared by:

Landscape Architect



693 East 82nd Street Indianapolis, IN 46240 312.213.7686 J2-designstudio.com

Project Location Map

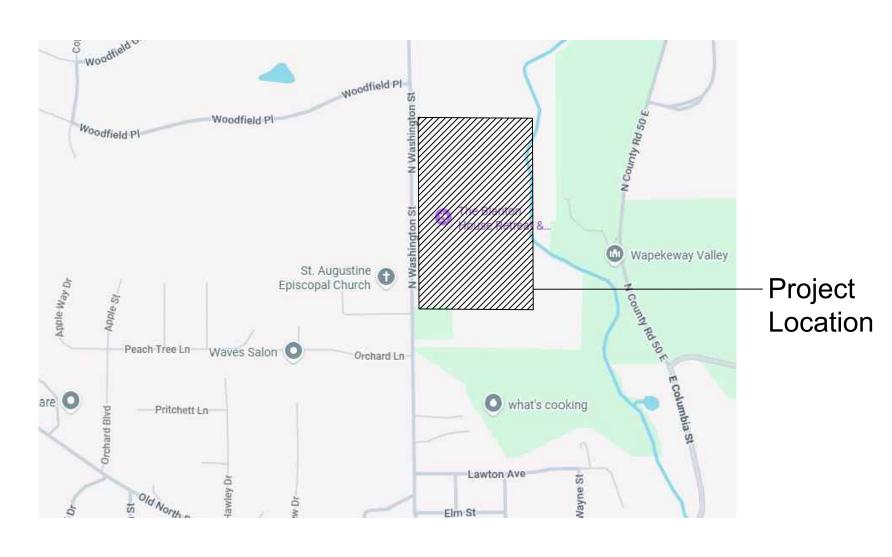

L0.0 Cover Sheet L1.0 Site Survey

Sheet Index

2.0 Demolition Plan

L3.0 Key Plan

L4.0 Grading and Drainage Plan EnlargementL4.1 Grading and Drainage Plan Enlargement

L5.0 Landscape Plan Enlargement

L5.1 Landscape Plan Enlargement

L5.2 Planting Schedule & DetailsL6.0 Site Details

Design Studio Com 312.213.7686

Design Street Indianapolis, IN 46240

Town of Danville Parks and Recreation

The Blanton
House
Front Entry
Improvements


625 North Washington Street, Danville, IN 46122

	1001155
	ISSUED October 2, 2025
	REVISIONS
No Date	Issue
CHECKED BY	DRAWN BY

SHEET TITLE
Cover Sheet

SCALE IN FEET



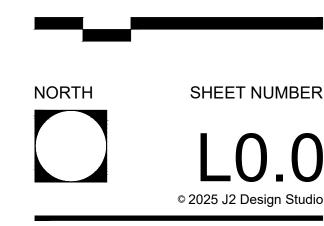

Design Studion Studion Studion Studion State | Urban Design Street Indianapolis, IN 46240

Town of Danville Parks and Recreation

The Blanton
House
Front Entry
Improvements

625 North Washington Street, Danville, IN 46122

October 2, 2025

REVISIONS


DRAWN BY

SHEET TITLE

Site Survey

© 2025 J2 Design Studio

VICINITY MAP

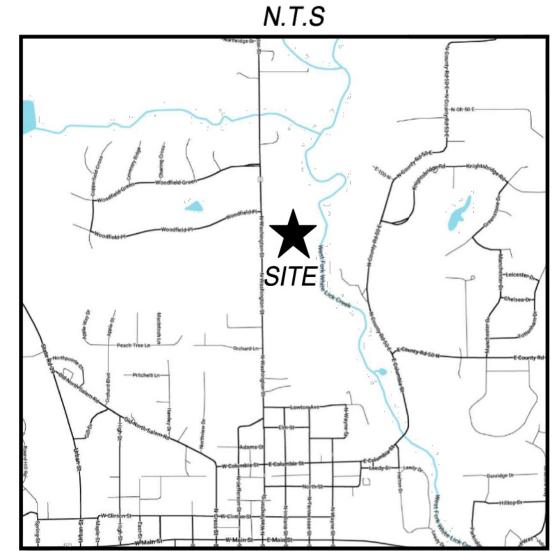

NOTES:

- 1. DISTANCE UNITS ARE BASED ON THE US SURVEY FOOT DEFINITION (1' = 1200/3937 METERS).
- 2. HORIZONTAL AND VERTICAL DATUMS ARE BASED ON THE INDIANA STATE PLANE COORDINATE SYSTEM WEST ZONE (1302) AS DERIVED FROM INDOT'S (VIRTUAL REFERENCE STATION) SYSTEM (NAD '83 (2011)) (NAVD '88). THE GEOID USED WAS GEOID 18.
- 3. SITE BENCHMARK AS SHOWN HEREON.
- 4. TOPOGRAPHIC INFORMATION IS BASED ON CONVENTIONAL SURVEYING METHODS.

SURVEY NOTES

- Original survey provided by The Kleingers Group in September 2025.
- Site survey has been clipped to fit onto sheet.
 Originals are available as requested.

NOTE:
UNDERGROUND UTILITIES ARE PLOTTED FROM A
COMPILATION OF AVAILABLE RECORD INFORMATION AND
SURFACE INDICATIONS OF UNDERGROUND STRUCTURES AND
MAY NOT BE INCLUSIVE. PRECISE LOCATIONS AND THE
EXISTENCE OR NON EXISTENCE OF UNDERGROUND UTILITIES
CANNOT BE VERIFIED. PLEASE NOTIFY THE INDIANA UTILITY
PROTECTION SERVICE AT 811 OR 1-800-382-5544 BEFORE ANY
PERIOD OF EXCAVATION OR CONSTRUCTION ACTIVITY.






No Date


CHECKED BY

SHEET NUMBER

L1.0

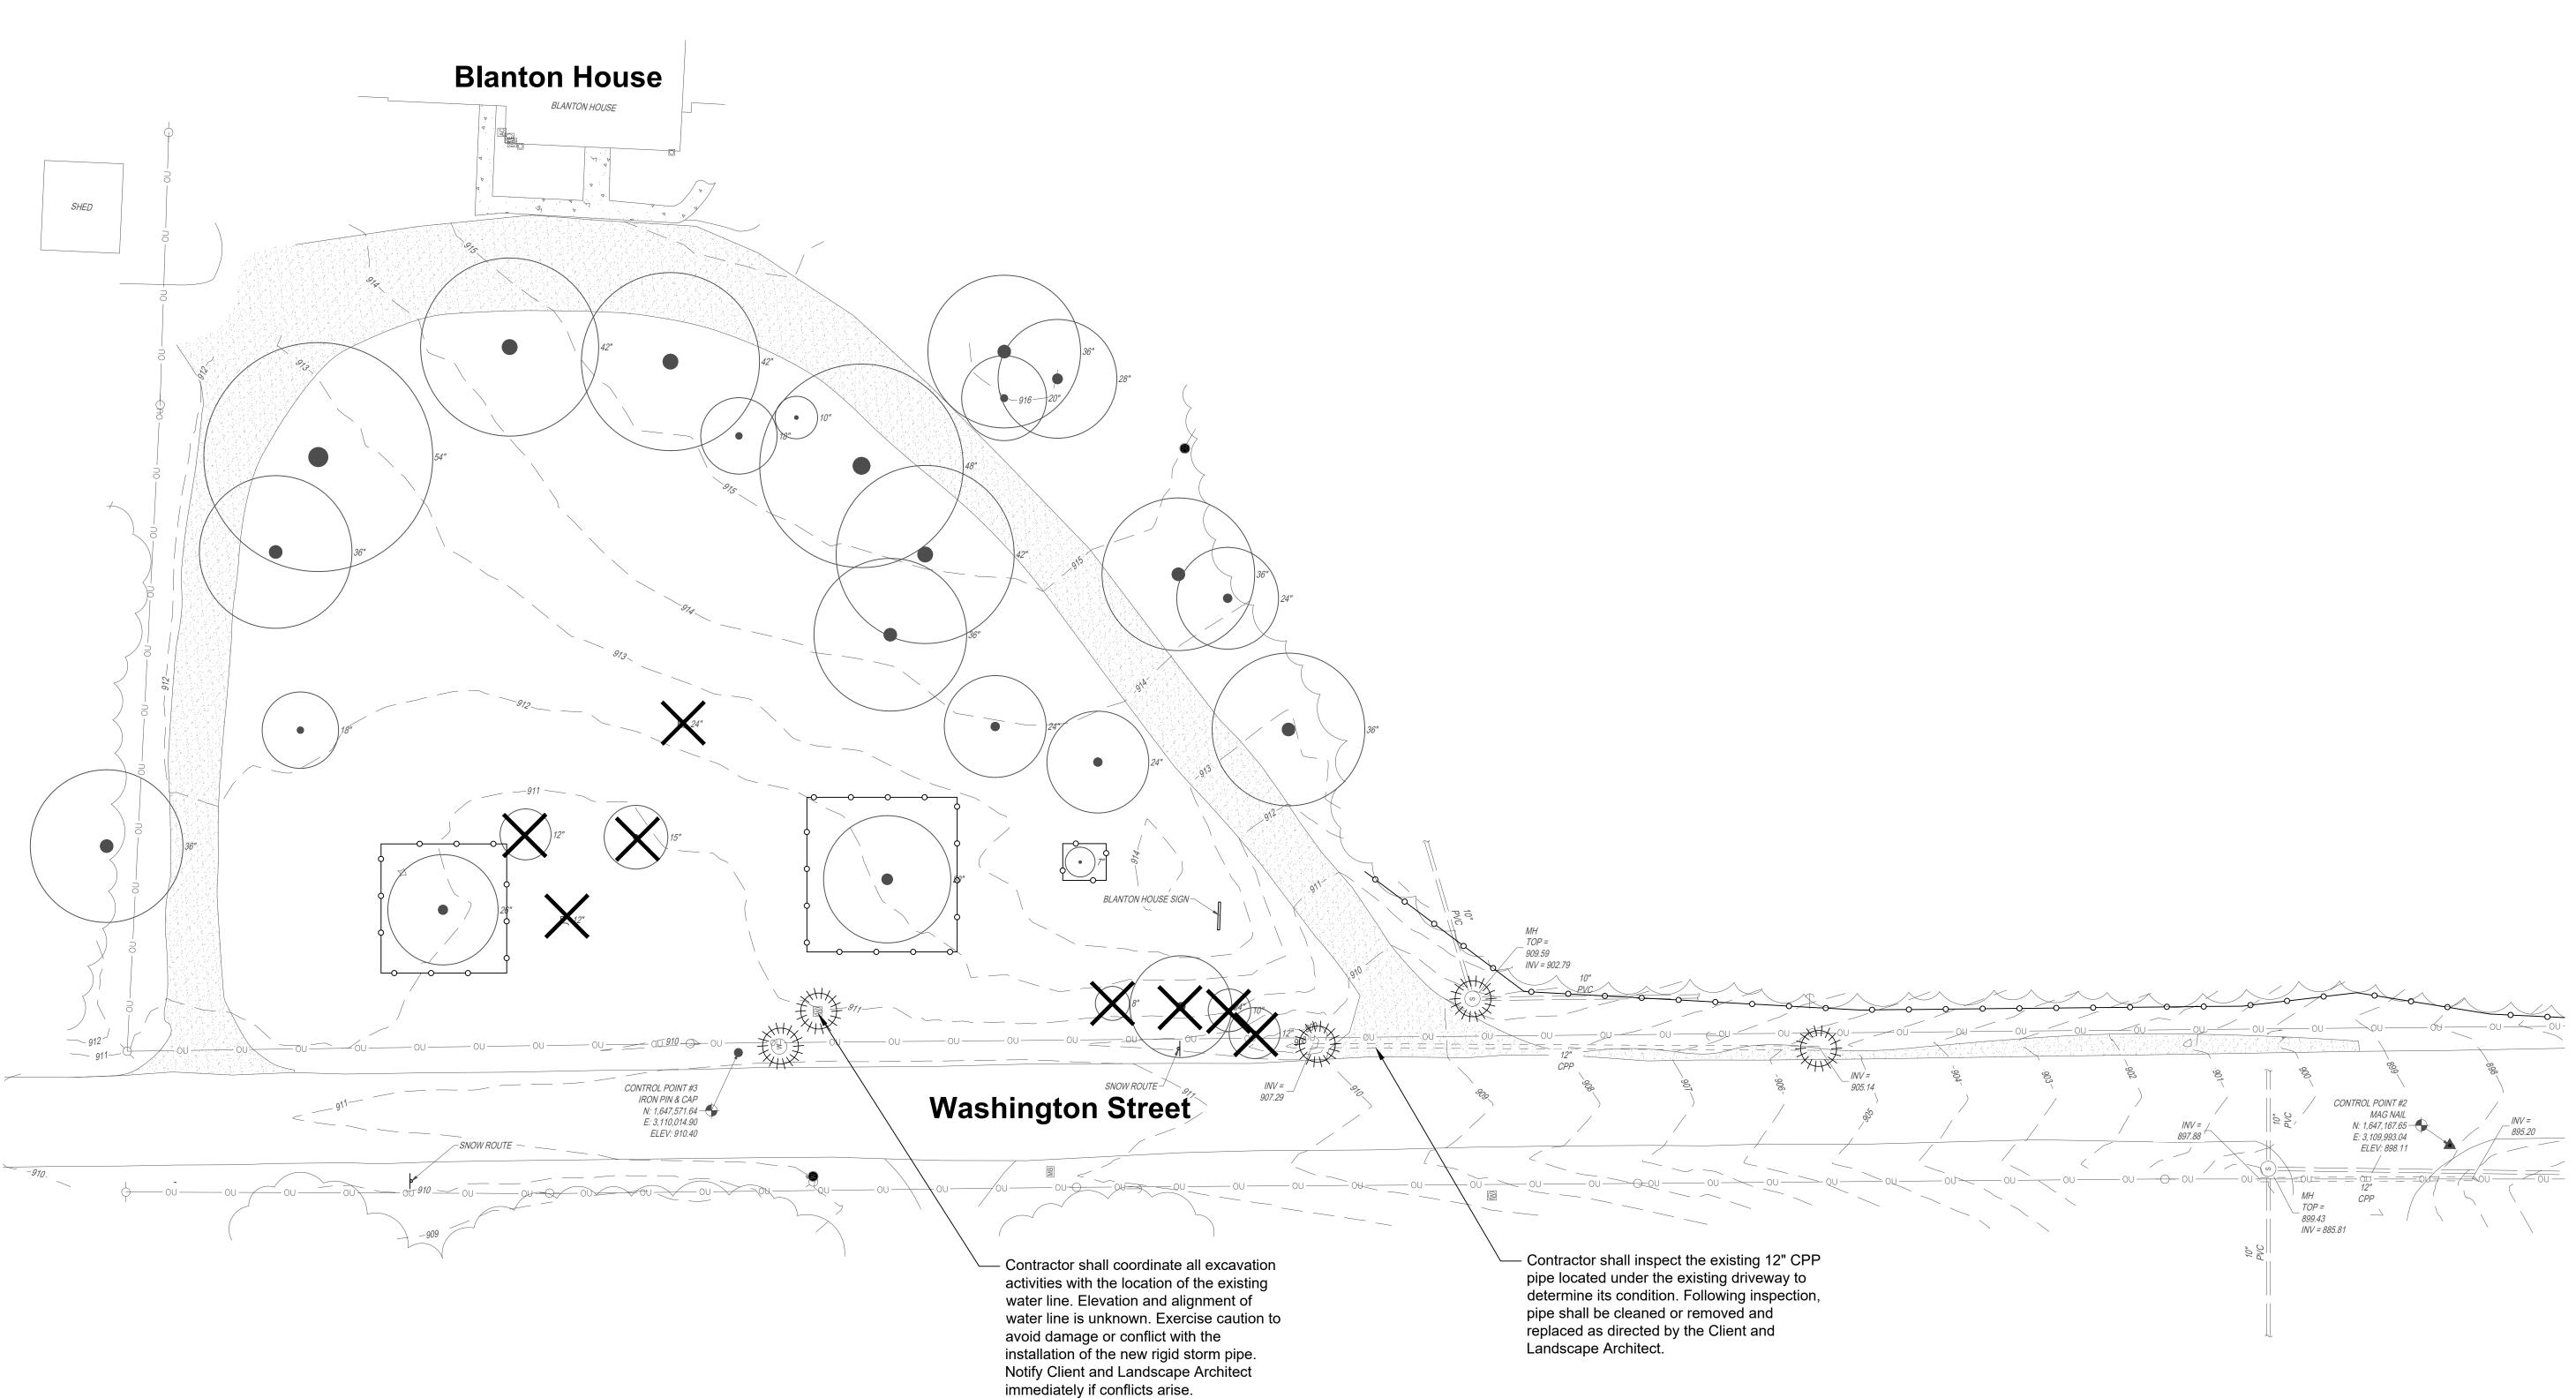

LEGEND

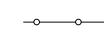

Tree protection fencing. See Detail 1 & 2, Sheet L5.2



Item to be removed



Utility protection

DEMOLITION NOTES

- Drawings indicate general locations and limits of removals. Contractor shall perform removals only as required for construction of improvements and as indicated on drawings. If additional demolition is completed, contractor is responsible to repair or restore to the original condition at contractor's own expense.
- Contractor shall install erosion control measures prior to commencing construction operations. Maintain erosion control measures as necessary during construction and remove prior to substantial completion.
- 3. Tree protection fencing to be installed prior to and maintained throughout construction period. No storage of materials, vehicular access or any other construction activities whatsoever permitted within the tree protection barriers, unless noted on plan.
- 4. Protect items designated to remain. Contractor shall repair or replace all damaged items to condition equal to or better than condition prior to construction.
- 5. 'Removal' shall include complete removal of above grade items and below grade items including, but not limited to, foundations, aggregate base, wiring, and piping that are immediately adjacent to the item being removed.

- 6. Where trees or stumps are to be removed, grind out stump to a depth of 18".
- 7. Refer to grading and drainage drawings for additional utility adjustments, removals or abandonment.
- Protect catch basins, drains, sewer inlets, utilities etc from debris and sedimentation during demolition and construction. Install geotextile filter fabric below inlet castings on or off-site that receive storm water from construction activities.
- 9. If discrepancies are discovered between construction documents and existing site conditions during demolition and construction operations contact the Landscape Architect immediately for resolution.

Design Studion Design
693 East 82nd Street Indianapolis, IN 46240

Town of Danville Parks and Recreation

The Blanton
House
Front Entry
Improvements

625 North Washington Street, Danville, IN 46122

> ISSUED October 2, 2025 REVISIONS


No	Date	Issue

CHECKED BY JS

SHEET TITLE


DRAWN BY

Demolition Plan

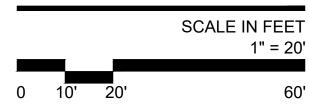



L2.0
© 2025 J2 Design Studio

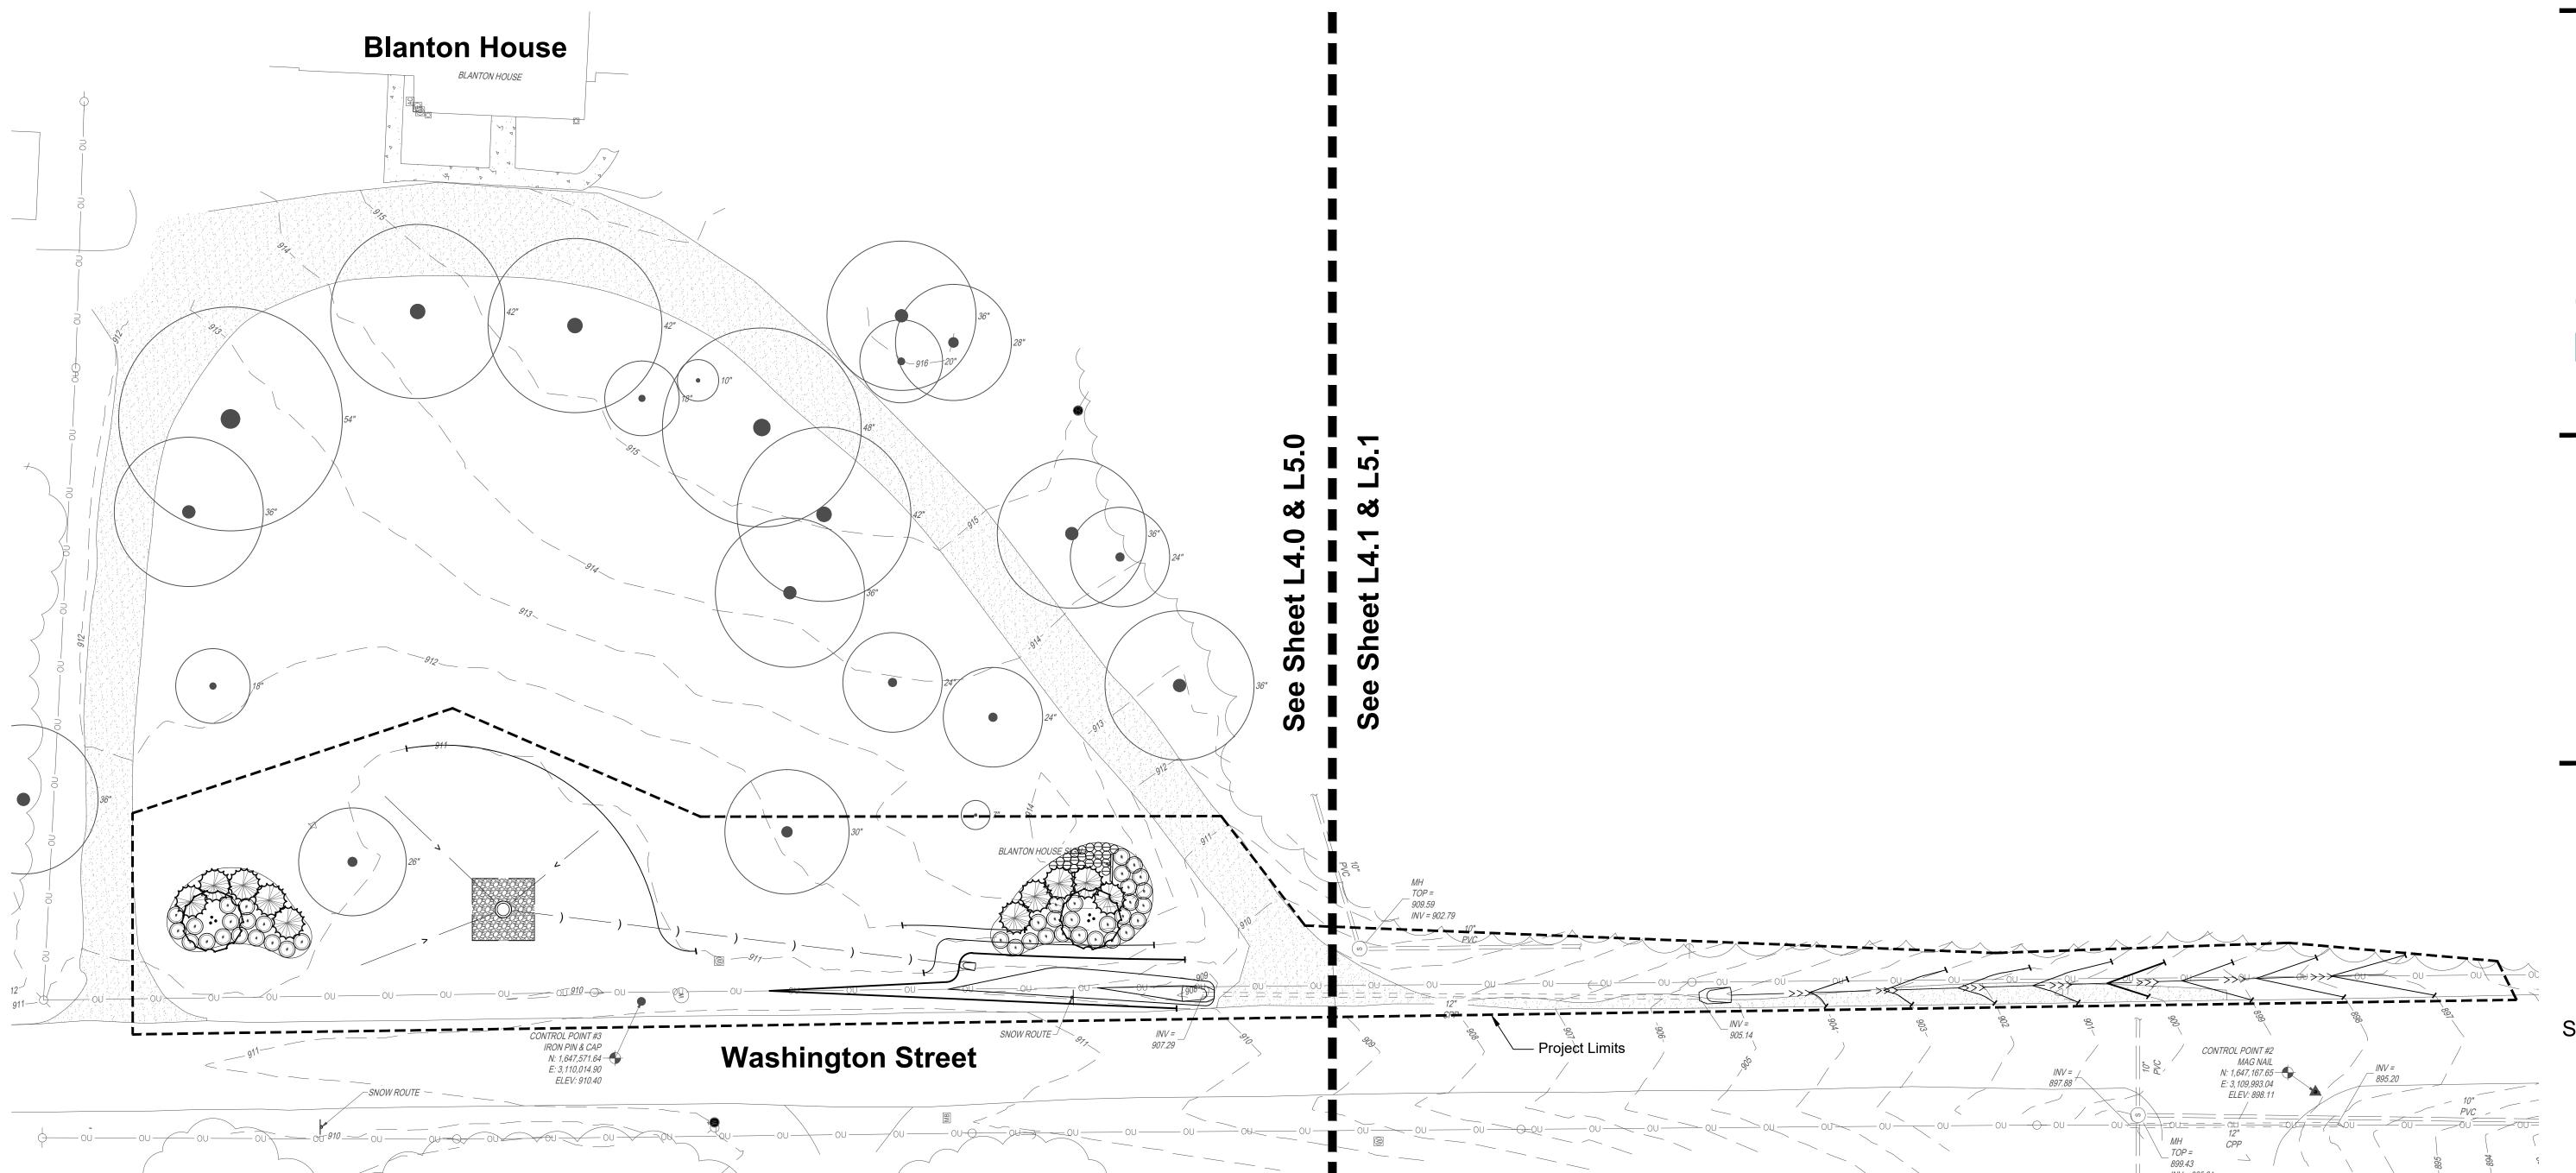

Design Studio.com

Sandscape Architecture | Urban Design

Sandscape Architecture | Urban Design

Sand Street Indianapolis, IN 46240

J2-designstudio.com

Town of Danville Parks and Recreation

The Blanton
House
Front Entry
Improvements


625 North Washington Street, Danville, IN 46122

	ISSUEI October 2, 202				
	REVISIONS				
		REVISIONS			
No	Date	Issue			

SHEET TITLE

Key Plan


DRAWN BY

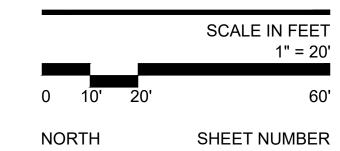



CHECKED BY

L3.0
© 2025 J2 Design Studio

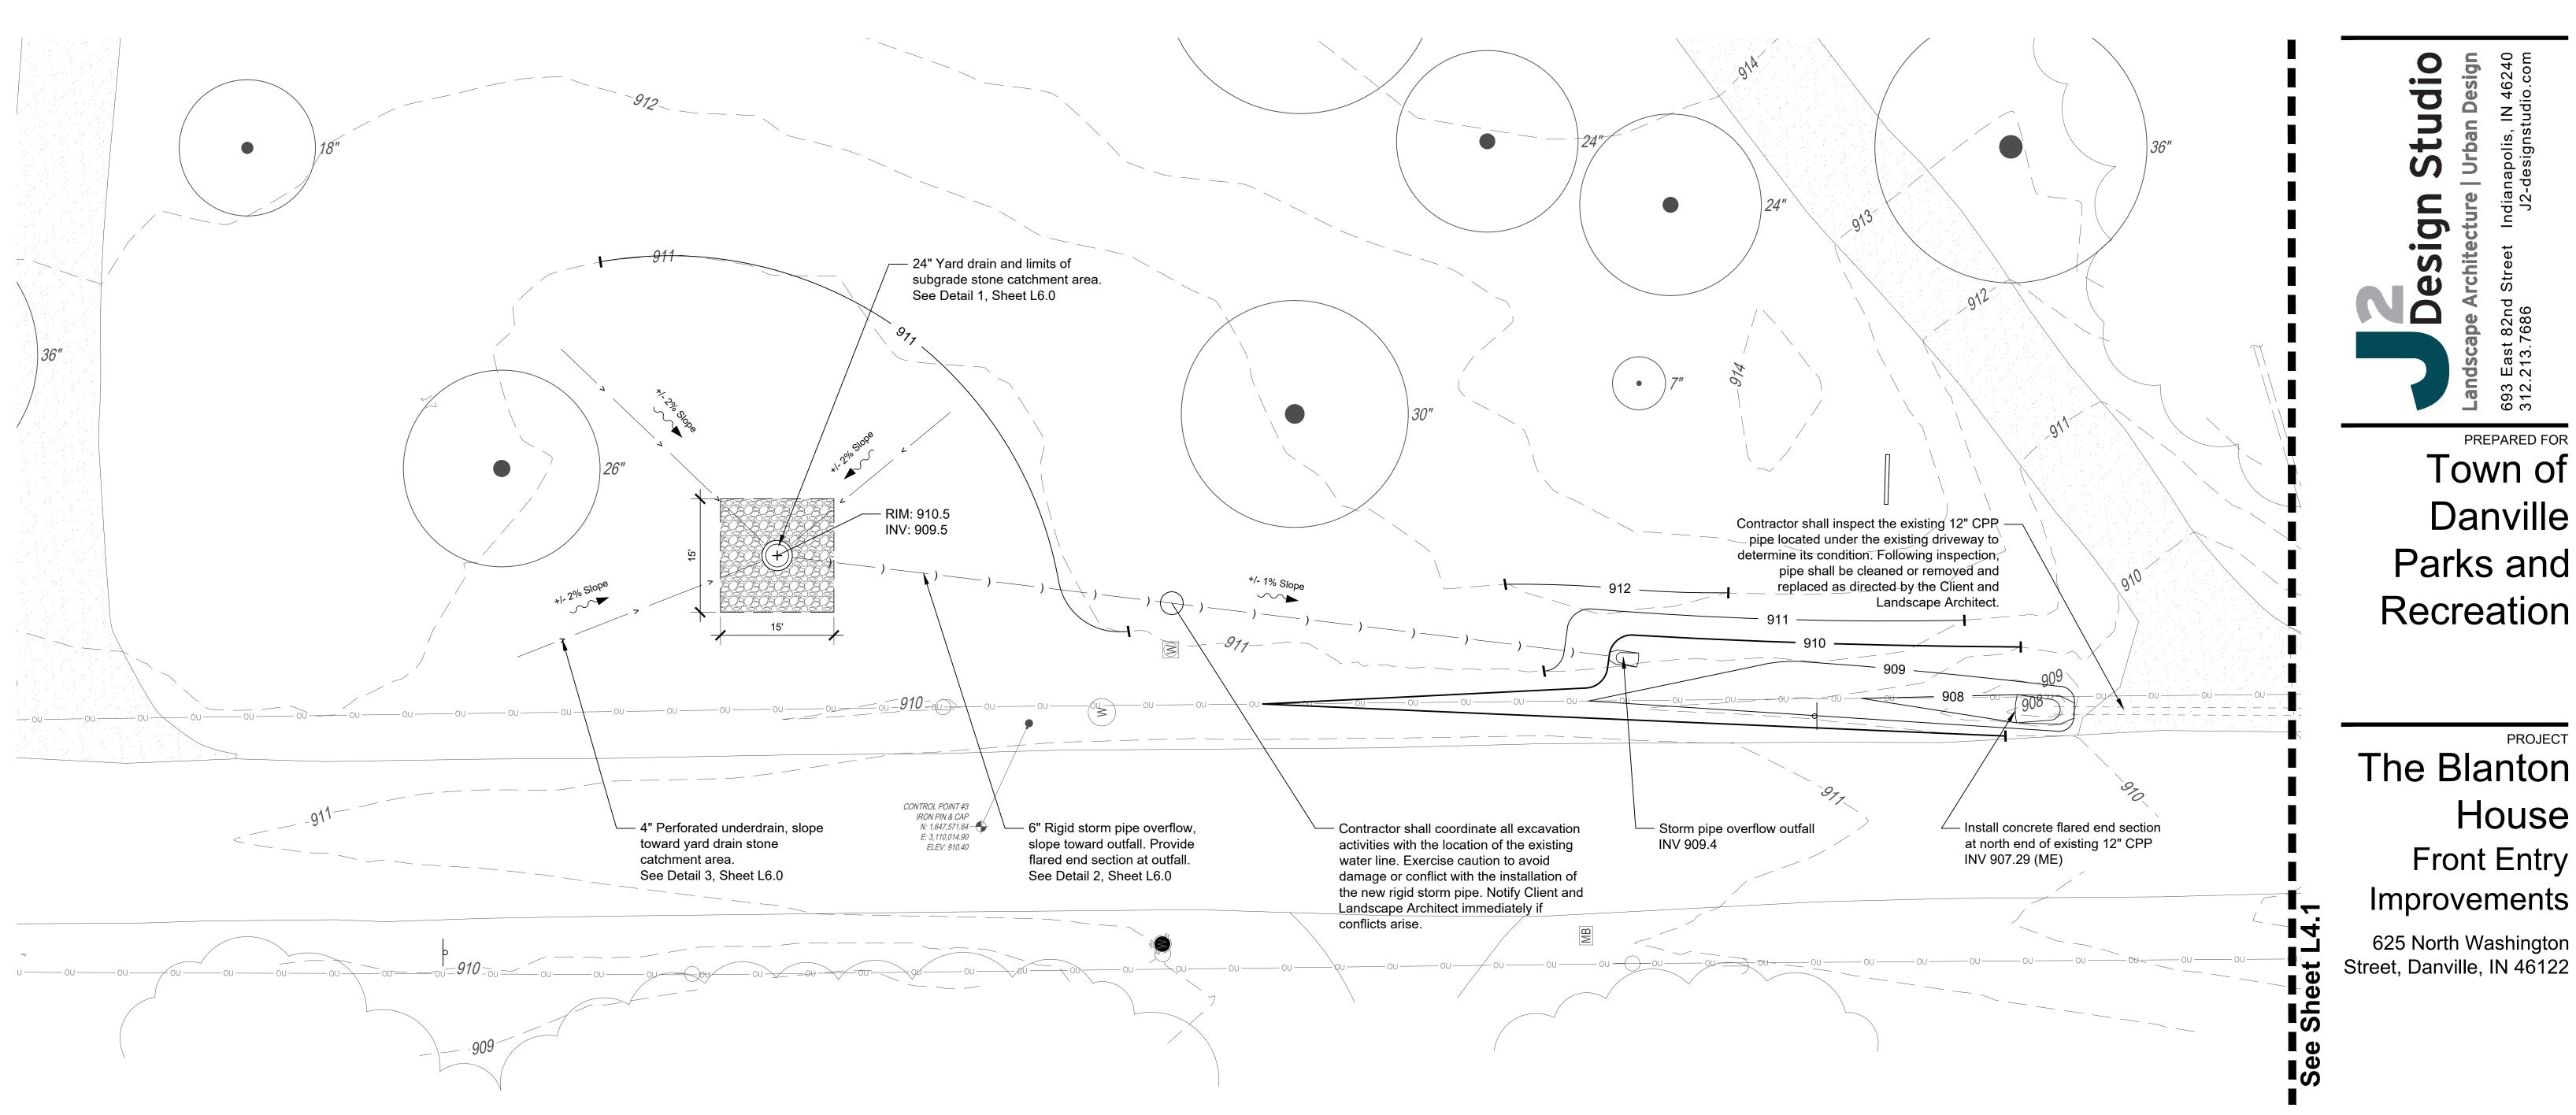

GENERAL NOTES

Yard Drain and Limits of Subgrade Stone Catchment Area See Detail 1, Sheet L6.0

> Rigid Storm Pipe See Detail 2, Sheet L6.0

Perforated Underdrain See Detail 3, Sheet L6.0

Concrete Flared End Section See Detail 4, Sheet L6.0

Swale flowline

LEGEND

├── 910 ──**/** Proposed Grade

- 1. Contractor shall verify all utility locations (existing and proposed) along with existing conditions and grades (existing and proposed), and note any discrepancies to Owner, Engineer, and Landscape Architect immediately, before proceeding with any work.
- 2. Base information for these plans was taken from the site survey. Contractor shall verify all dimensions and locations of existing and proposed features, and familiarize themselves with any obstacles encumbering the work of this project.
- Contractor is responsible for field layout of all new improvements. The Landscape Architect is to verify in field all layout and locations prior to installation. Contact Landscape Architect for resolution of discrepancies between existing conditions and design intent as expressed in contract documents.
- 4. Contractor is responsible for maintaining or adjusting elevation in work area to not impact existing street signage, utilities, or other improvements identified to remain.

ISSUED October 2, 2025 **REVISIONS**

No Date Issue

Studio

PREPARED FOR

Town of

Danville

House

Front Entry

Improvements

625 North Washington

Parks and

Recreation

CHECKED BY

SHEET TITLE


DRAWN BY

Grading and Drainage Plan Enlargement

SCALE IN FEET 1" = 10'



© 2025 J2 Design Studio

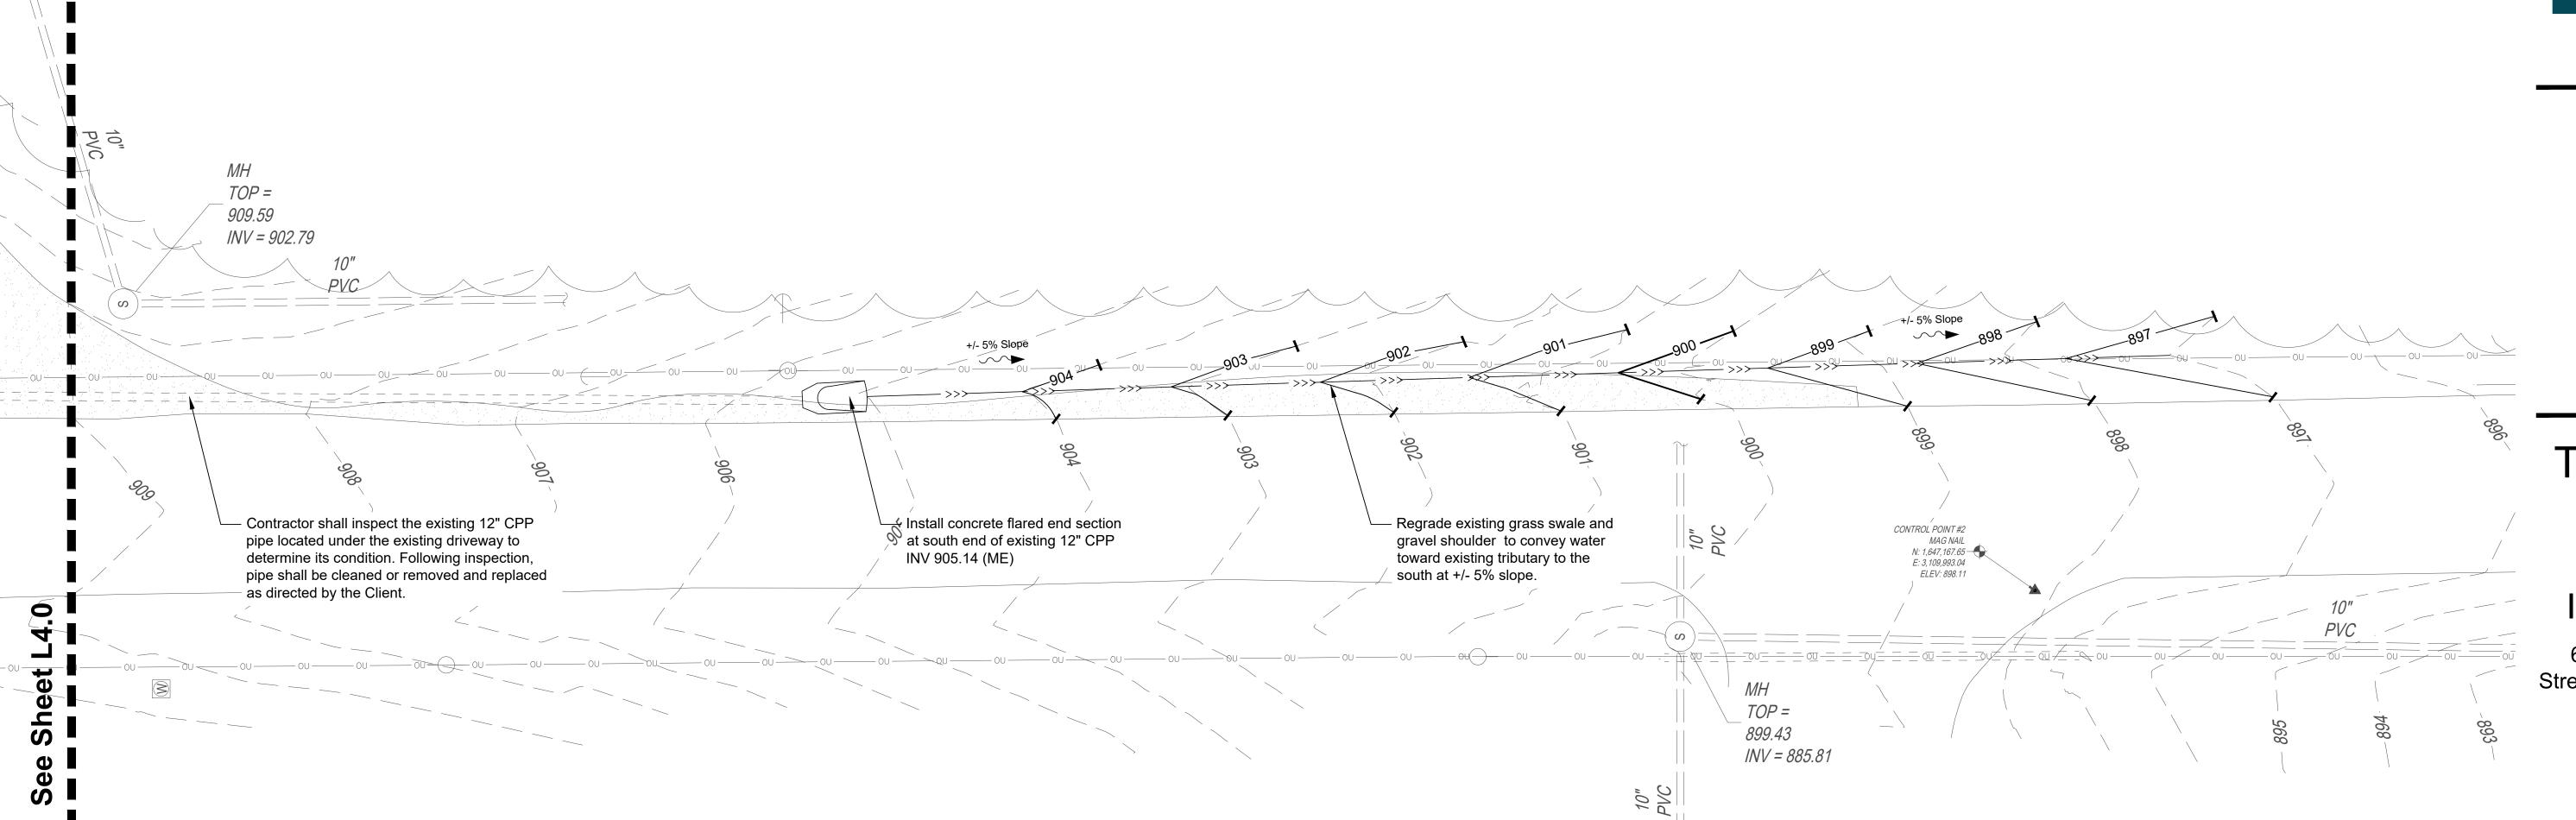

Landscape Architecture | Urban Design 693 East 82nd Street Indianapolis, IN 46240

Town of Danville Parks and Recreation

The Blanton
House
Front Entry
Improvements

625 North Washington Street, Danville, IN 46122

LEGEND

Yard Drain and Limits of Subgrade Stone Catchment Area See Detail 1, Sheet L6.0

Rigid Storm Pipe See Detail 2, Sheet L6.0

____> ___

Perforated Underdrain See Detail 3, Sheet L6.0

Swale flowline

Concrete Flared End Section See Detail 4, Sheet L6.0

----->>>

├── 910 ── **Proposed Grade**

GENERAL NOTES

- Contractor shall verify all utility locations (existing and proposed) along with existing conditions and grades (existing and proposed), and note any discrepancies to Owner, Engineer, and Landscape Architect immediately, before proceeding with any work.
- Base information for these plans was taken from the site survey. Contractor shall verify all dimensions and locations of existing and proposed features, and familiarize themselves with any obstacles encumbering the work of this project.
- 3. Contractor is responsible for field layout of all new improvements. The Landscape Architect is to verify in field all layout and locations prior to installation. Contact Landscape Architect for resolution of discrepancies between existing conditions and design intent as expressed in contract documents.
- Contractor is responsible for maintaining or adjusting elevation in work area to not impact existing street signage, utilities, or other improvements identified to remain.

ISSUED October 2, 2025 REVISIONS

No	Date	Issue

CHECKED BY JS


KED BY DRAWN BY JS SHEET TITLE

Grading and
Drainage Plan
Enlargement

SCALE IN FEET 1" = 10' 5' 10' 30'



L4 1
© 2025 J2 Design Studio

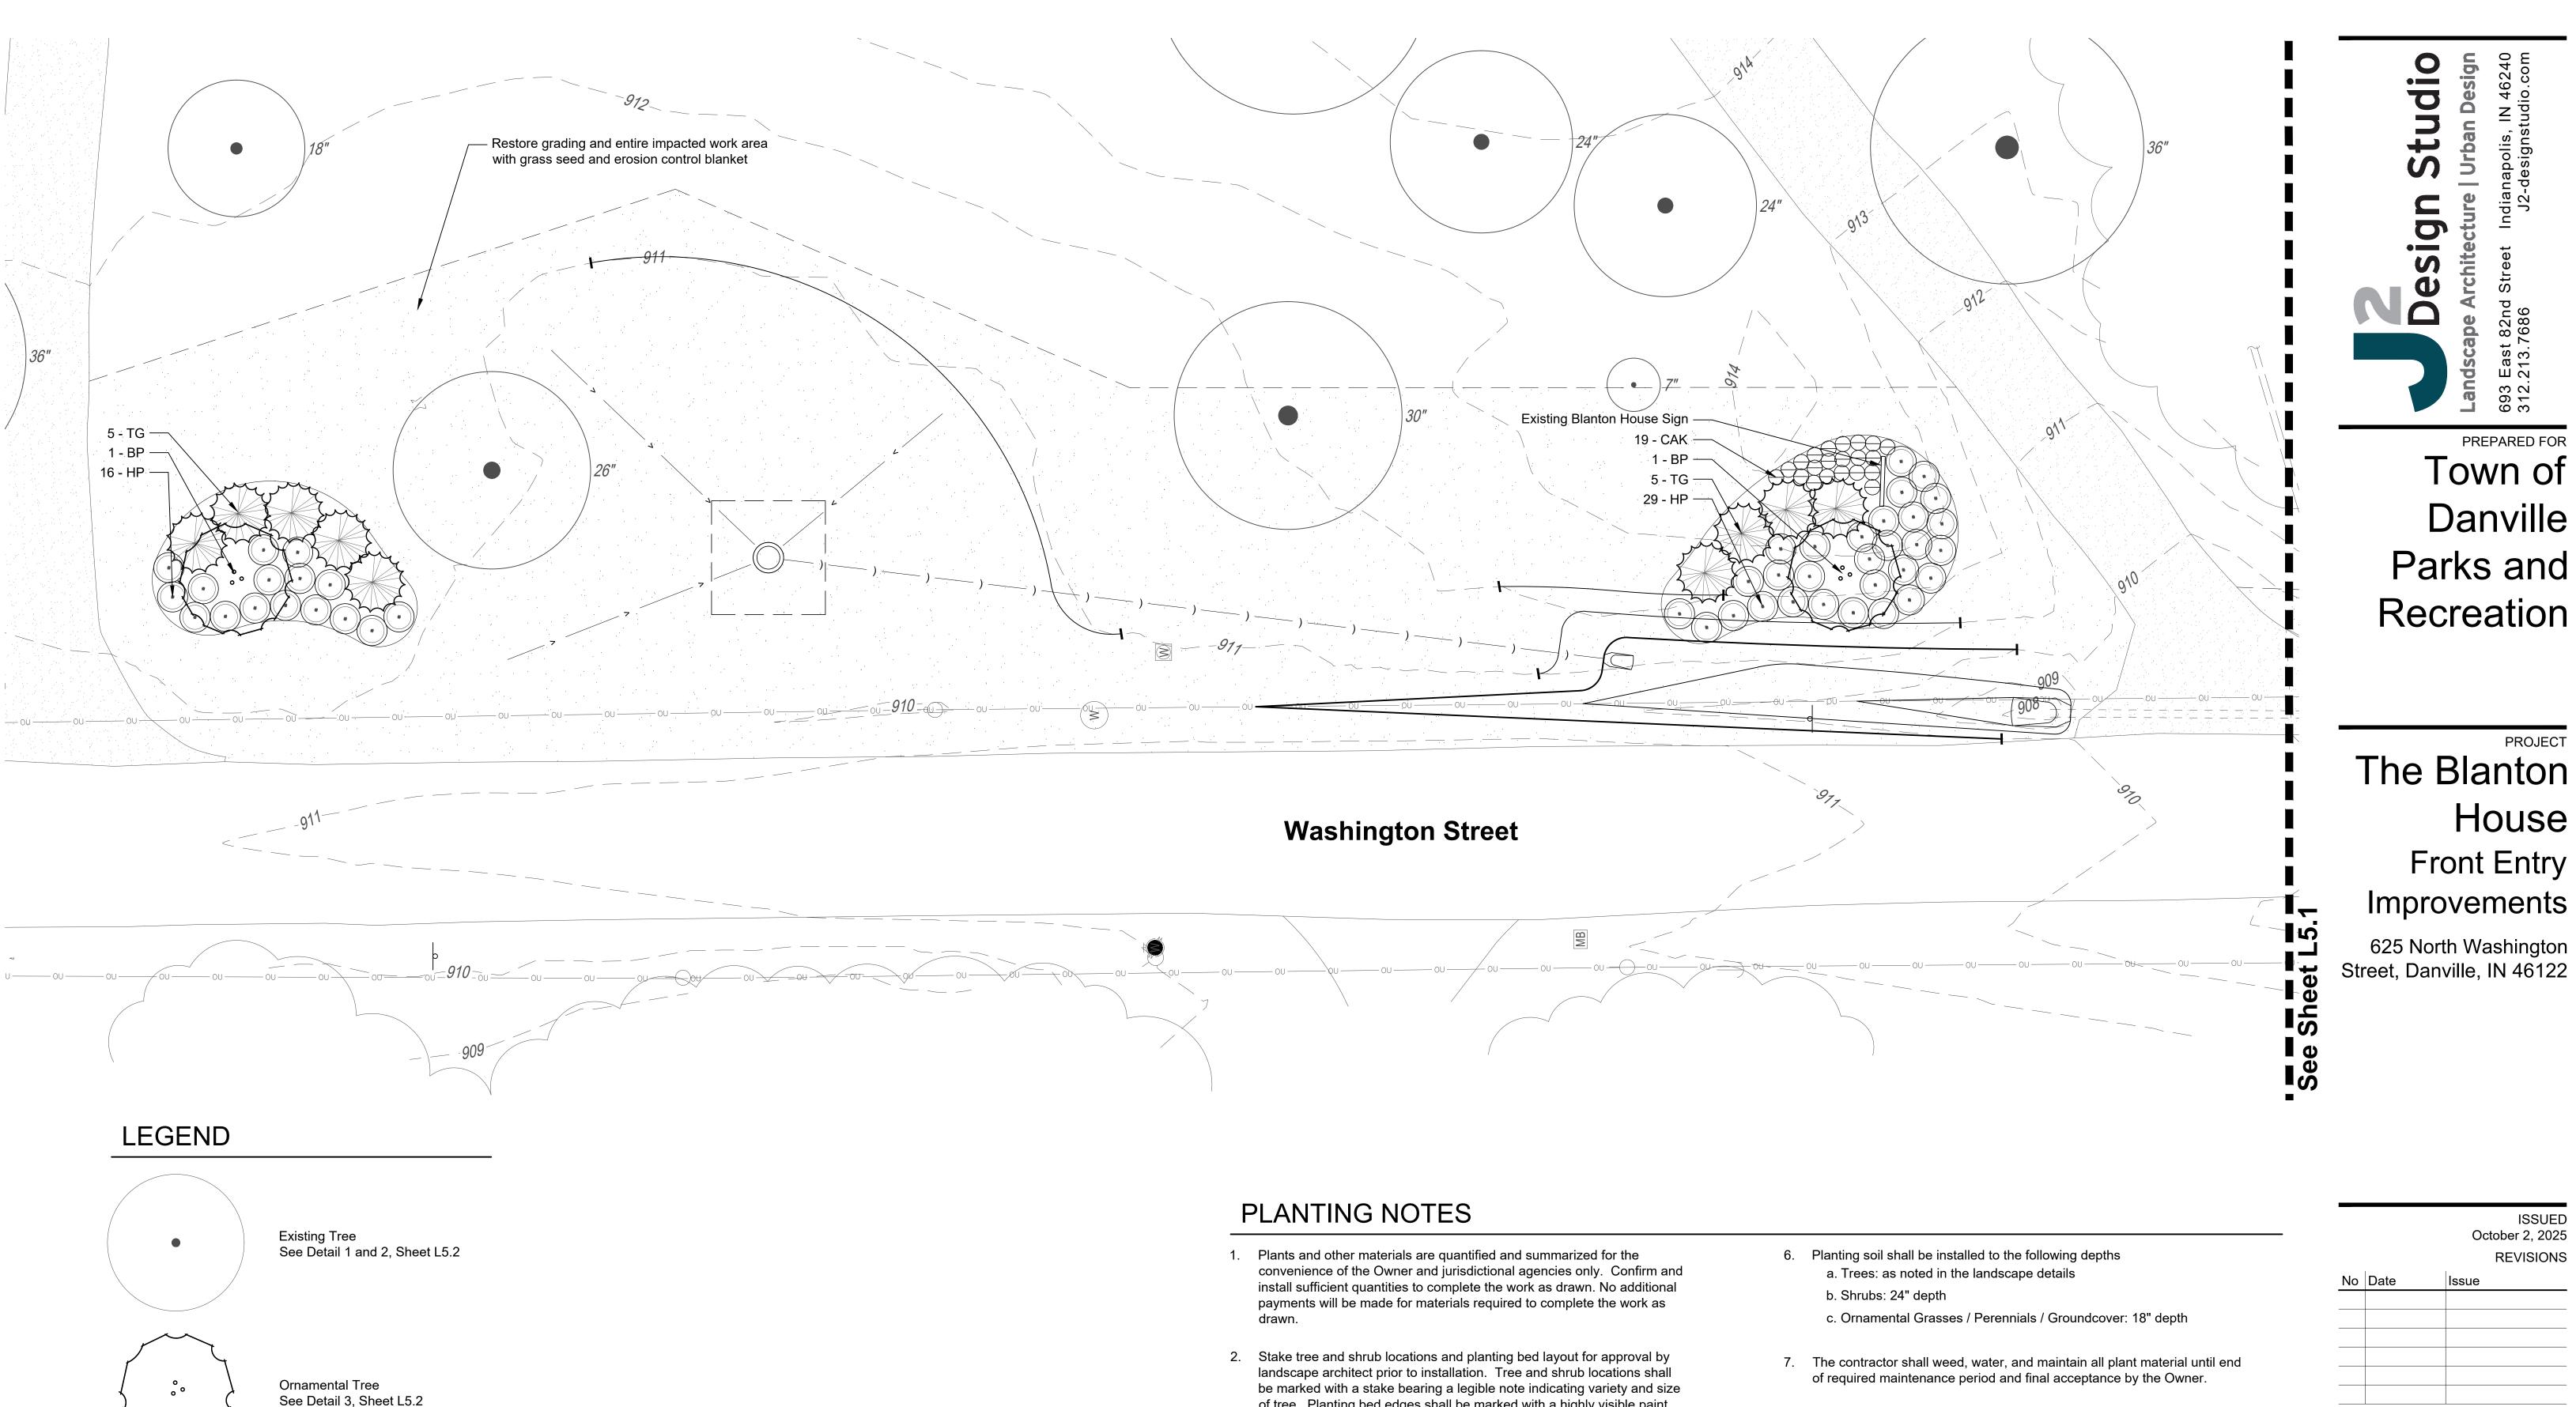

Evergreen Tree

Ornamental Grass

Lawn Seed

 \ominus

See Detail 4, Sheet L5.2

See Detail 5 and 7, Sheet L5.2

See Detail 6 and 7, Sheet L5.2

- of tree. Planting bed edges shall be marked with a highly visible paint line. Stakes shall be removed prior to substantial completion. Landscape Architect reserves the right to make adjustments to plant locations. Plant material installed in incorrect locations shall be reinstalled at no additional cost.
- 3. Do not locate plants within 10' of utility structures or within 5' horizontally of underground utility lines unless noted otherwise on drawings.
- 4. Substitutions of plant materials shall not be allowed. If plants are not available, the contractor shall notify the landscape architect prior to the bid in writing. All plants shall be inspected and tagged with project identification at nursery or contractor's operations prior to moving to the site. Landscape Architect reserves the right to reject plant materials on-site that do not meet project requirements.
- 5. All planting soil, whether from on-site or imported, shall be tested as identified in the specifications. Submit testing agency with laboratory report to Landscape Architect for approval, along with recommendations to amending soil as appropriate for use in planting.

- 8. Contractor shall guarantee and warranty plant materials for a period of one full year following planting substantial completion.
- 9. Planting beds and tree mulch rings shall have a shovel cut spaded edge vertically cut to a depth of 2".
- 10. Tree mulch rings shall be covered with a 3" thickness of shredded hardwood bark mulch. Bark mulch shall be approved by Landscape Architect and be uniform in color and texture. Utility mulch or process tree trimmings will not be allowed.
- 11. Tree mulch rings in lawn areas shall have a 5' diameter unless noted otherwise on drawings.
- 12. Lawn seed or sod limits are approximate. Sow seed or lay sod to limits of grading and disturbance. Contractor shall be responsible for restoration of unauthorized disturbance outside construction limits.

ISSUED October 2, 2025 REVISIONS Issue

PREPARED FOR

Town of

Danville

House

Front Entry

No Date

DRAWN BY **CHECKED BY**

> SHEET TITLE Landscape Plan Enlargement

SCALE IN FEET

SHEET NUMBER © 2025 J2 Design Studio

PLANTING NOTES

- 1. Plants and other materials are quantified and summarized for the convenience of the Owner and jurisdictional agencies only. Confirm and install sufficient quantities to complete the work as drawn. No additional payments will be made for materials required to complete the work as
- 2. Stake tree and shrub locations and planting bed layout for approval by landscape architect prior to installation. Tree and shrub locations shall be marked with a stake bearing a legible note indicating variety and size of tree. Planting bed edges shall be marked with a highly visible paint line. Stakes shall be removed prior to substantial completion. Landscape Architect reserves the right to make adjustments to plant locations. Plant material installed in incorrect locations shall be reinstalled at no additional cost.
- 3. Do not locate plants within 10' of utility structures or within 5' horizontally of underground utility lines unless noted otherwise on drawings.
- 4. Substitutions of plant materials shall not be allowed. If plants are not available, the contractor shall notify the landscape architect prior to the bid in writing. All plants shall be inspected and tagged with project identification at nursery or contractor's operations prior to moving to the site. Landscape Architect reserves the right to reject plant materials on-site that do not meet project requirements.
- 5. All planting soil, whether from on-site or imported, shall be tested as identified in the specifications. Submit testing agency with laboratory report to Landscape Architect for approval, along with recommendations to amending soil as appropriate for use in planting.

- 6. Planting soil shall be installed to the following depths
 - a. Trees: as noted in the landscape details
 - b. Shrubs: 24" depth
 - c. Ornamental Grasses / Perennials / Groundcover: 18" depth
- 7. The contractor shall weed, water, and maintain all plant material until end of required maintenance period and final acceptance by the Owner.
- 8. Contractor shall guarantee and warranty plant materials for a period of one full year following planting substantial completion.
- 9. Planting beds and tree mulch rings shall have a shovel cut spaded edge vertically cut to a depth of 2".
- 10. Tree mulch rings shall be covered with a 3" thickness of shredded hardwood bark mulch. Bark mulch shall be approved by Landscape Architect and be uniform in color and texture. Utility mulch or process tree trimmings will not be allowed.
- 11. Tree mulch rings in lawn areas shall have a 5' diameter unless noted otherwise on drawings.
- 12. Lawn seed or sod limits are approximate. Sow seed or lay sod to limits of grading and disturbance. Contractor shall be responsible for restoration of unauthorized disturbance outside construction limits.

PREPARED FOR Town of Danville Parks and Recreation

PROJECT The Blanton House Front Entry Improvements

625 North Washington Street, Danville, IN 46122

> ISSUED October 2, 2025 REVISIONS

No Date Issue


DRAWN BY **CHECKED BY**

SHEET TITLE

Landscape Plan Enlargement

SCALE IN FEET


SHEET NUMBER © 2025 J2 Design Studio

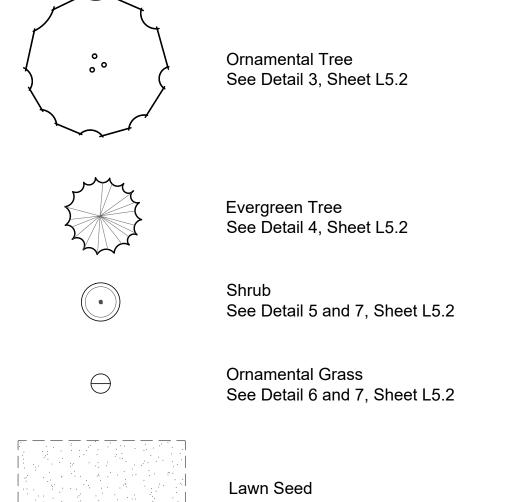


Existing Tree

See Detail 1 and 2, Sheet L5.2

Section - Tree Protection Fence Scale: 1" = 1'-0"

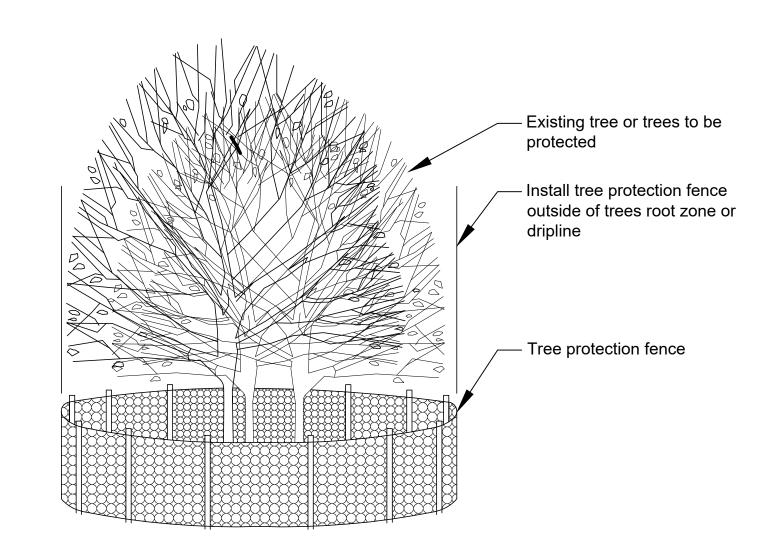


Axon - Tree Protection Fencing Scale: 1" = 1'-0"

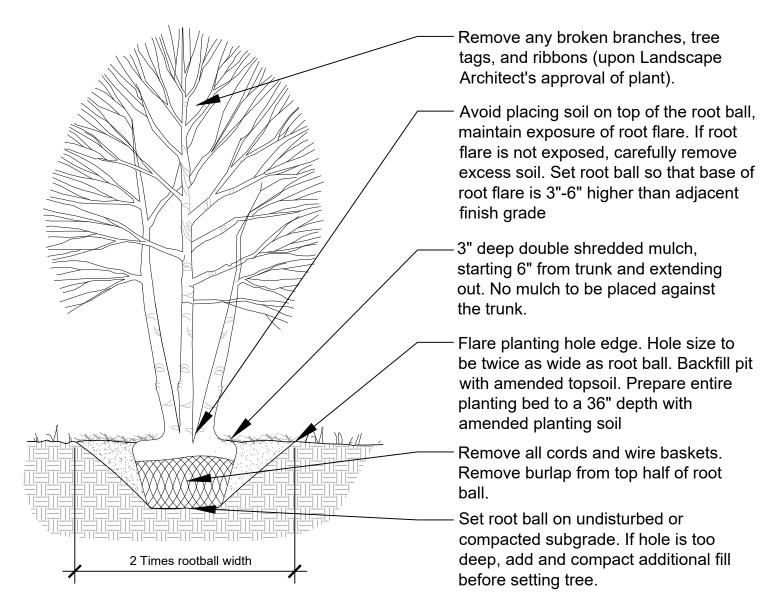


Scale: 1/2" = 1'-0"

Scale: 1/2" = 1'-0"

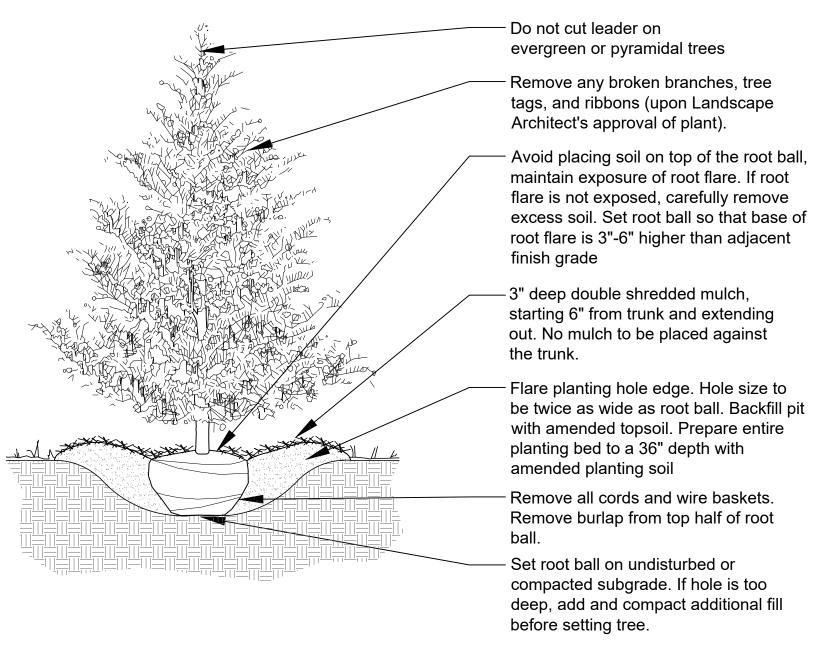

Section - Evergreen Tree Planting

Scale: 1/2" = 1'-0"

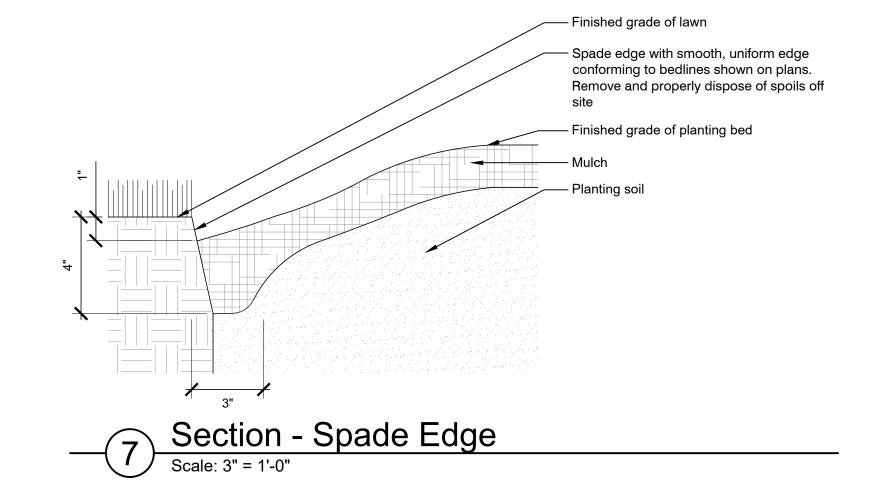

Limit pruning to dead and broken branches

Set rootball at same level as finished grade

3" deep double shredded mulch. Work mulch under branches. Raise planting bed 2" above finish grade

Prepare entire planting bed to a 24" depth with amended planting soil

Remove all cords and wire baskets. Remove burlap from top half of


rootball

subgrade

Set rootball on undisturbed

Section - Shrub Planting

Scale: 1/2" = 1'-0"

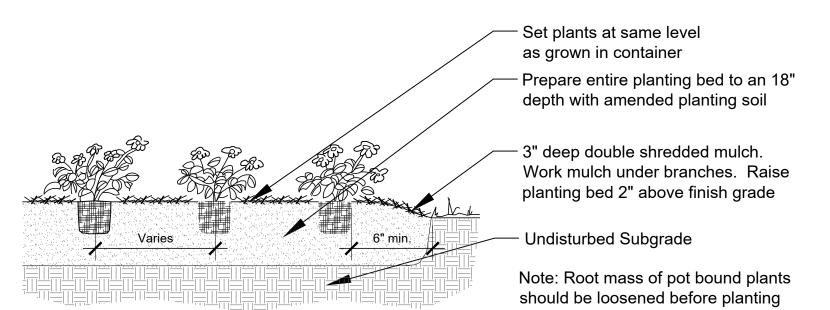

Section - Perennial / Ornamental Grass

Planting

Scale: 1/2" = 1'-0"

PLANT SCHEDULE

QTY	KEY	BOTANICAL NAME	COMMON NAME	SIZE	COMMENTS
ORNAME	NTAL TE	REES			
2	BP	Betula populifolia 'Whitespire'	Whitespire Birch	10' ht	Spacing as shown on plans
10	TG	Thuja 'Green Giant'	Green Giant Arborvitae	6' ht	Spacing as shown on plans
SHRUBS					
45	HP	Hydrangea paniculata 'Little Lime'	Little Lime Hydrangea	5 gal	Spacing as shown on plans
ORNAME	NTAL G	RASSES			
19	CAK	Calamagrostis acutiflora 'Karl Foerster'	Karl Foerster Feather Reed Grass	3 gal	Plant 24" on center

Town of Danville Parks and Recreation

Studio

2 Design

The Blanton
House
Front Entry
Improvements

625 North Washington Street, Danville, IN 46122

ISSUED October 2, 2025 REVISIONS No Date Issue

CHECKED BY DRAWN BY
JS JS


SHEET TITLE
Planting Schedule


& Details


SCALE IN FEET

NORTH

L5.2© 2025 J2 Design Studio

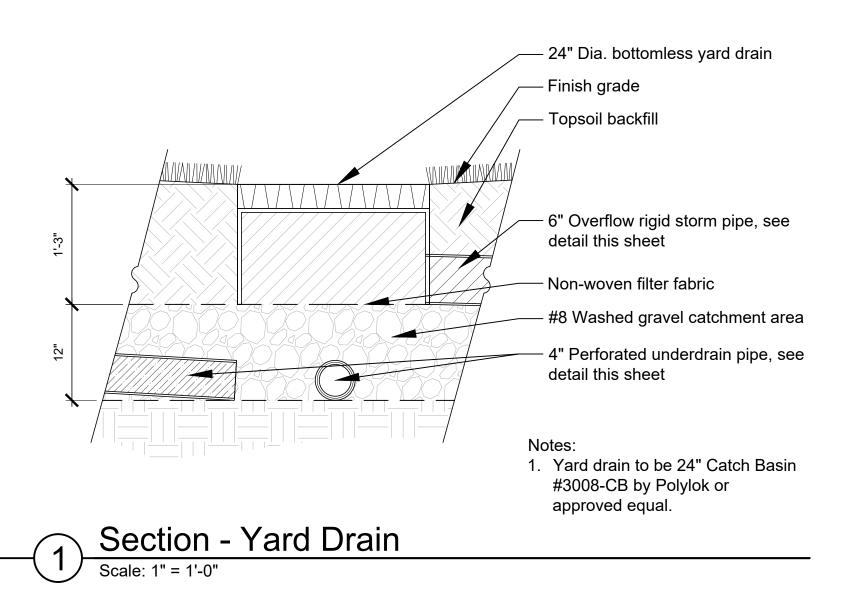


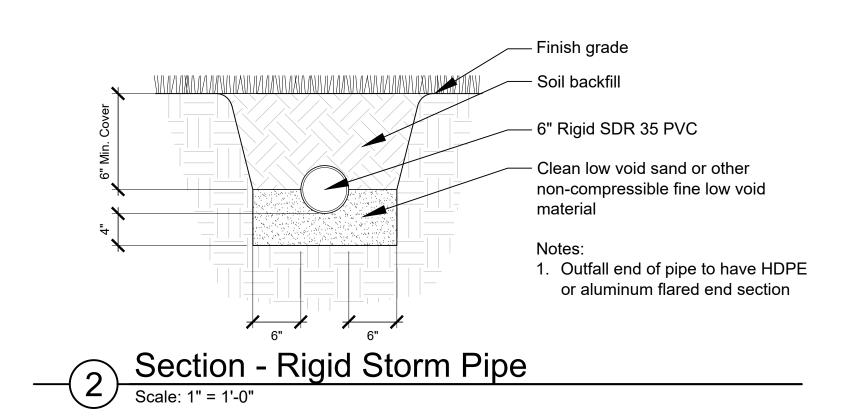

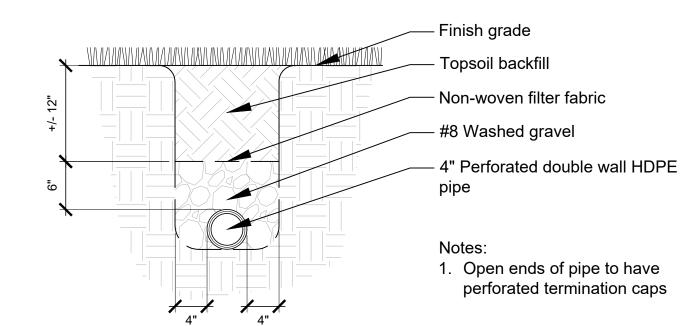

Scale: 1" = 1'-0"

Scale: 1" = 1'-0"

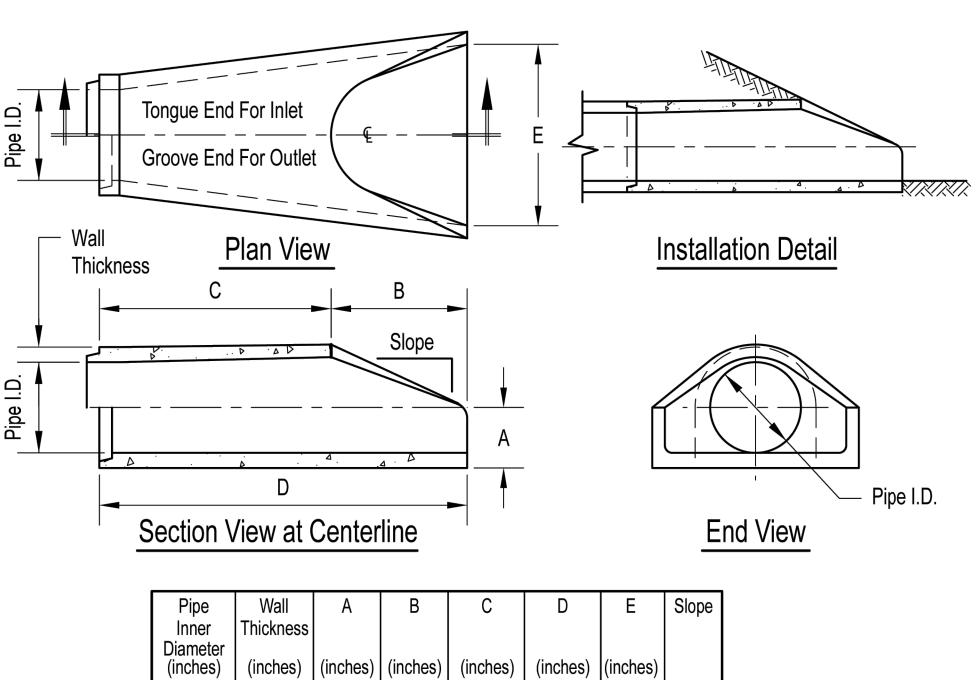

Pipe Inner	Wall Thickness	А	В	С	D	E	Slope
Diameter (inches)	(inches)	(inches)	(inches)	(inches)	(inches)	(inches)	
12	2	4	24	48 7/8	72 7/8	30	3:1
15	2 1/4	6	27	46	73	30	3:1
18	2 1/2	9	27	46	73	36	3:1
24	3	9 1/2	43 1/2	30	73 1/2	48	3:1
30	3 1/2	12	54	19 3/4	73 3/4	60	3:1
36	4	15	63	34 3/4	97 3/4	72	3:1
42	4 1/2	21	63	35	98	78	3:1
48	5	24	72	26	98	84	3:1
54	5 1/2	27	65	35	100	90	2.4:1
60	6	30	60	39	99	96	2:1
66	6 1/2	32	78	21	99	102	2:1
72	7	34	78	21	99	108	2:1

Dimensions may vary depending upon equipment availability.

____(4) Concrete Flared End Section

Design Studio Studio State Indianapolis, IN 46240 312.213.7686 J2-designstudio.com

Town of Danville Parks and Recreation

The Blanton
House
Front Entry
Improvements

625 North Washington Street, Danville, IN 46122

ISSUED October 2, 2025
REVISIONS
No Date Issue

CHECKED BY JS

SHEET TITLE
Site Details

DRAWN BY

SCALE IN FEET

NORTH

L6.0
© 2025 J2 Design Studio